


c:lbc-workspace/bolton_s/m-virtapp928s,d-high voltage/drawings/pe605 design services to aertech/027 - oriel windfarm 220 kv grid connection/pe605-d027-038-012-004.dwg

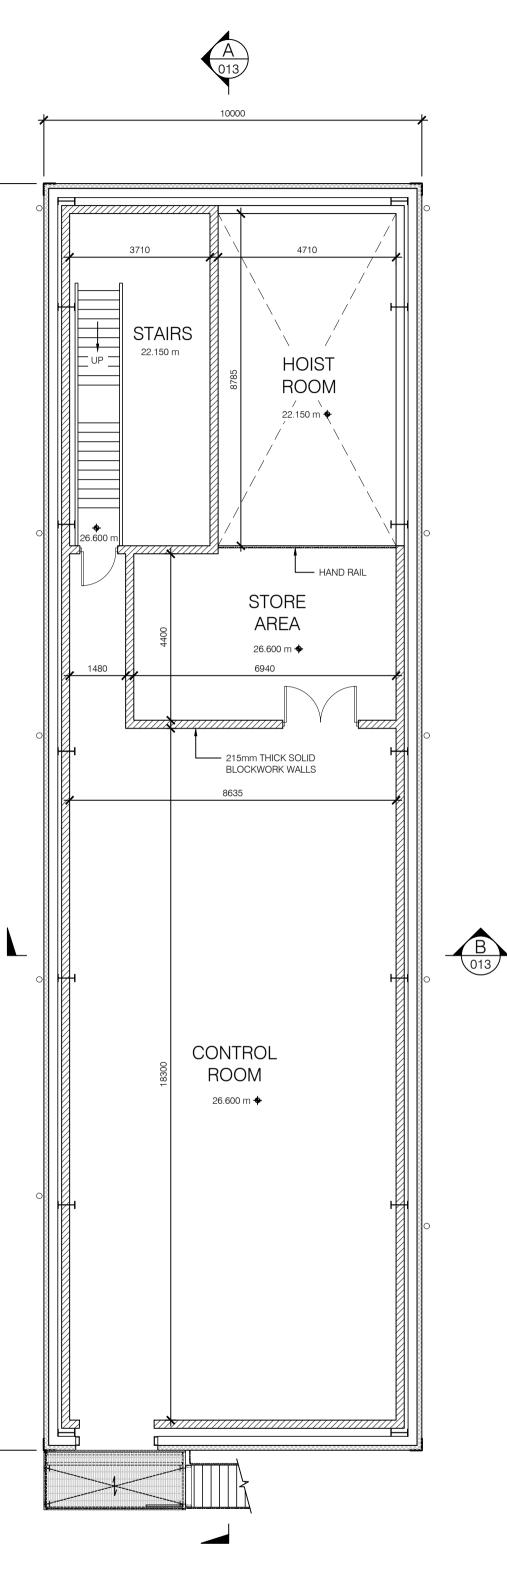

• 30.300 m TOP OF PARAPET ← FALL $\xrightarrow{}$ FALL < ⊢ FALL $\xrightarrow{\mathsf{FALL}}$

← FALL

 $\xrightarrow{\text{FALL}}$

FIRST FLOOR PLAN SCALE 1:100



 $\xrightarrow{}$ FALL

X

← FALL

NOTES:

- 1. ALL DIMENSIONS ARE IN mm. NO DIMENSIONS SHALL BE SCALED FROM THE DRAWINGS.
- THIS DRAWING IS PRODUCED FOR PLANNING PURPOSES ONLY. ALL DIMENSIONS AND REFERENCES GIVEN ARE SUBJECT TO DETAILED DESIGN. THIS DRAWING IS NOT FOR CONSTRUCTION.
- 3. CIVIL CALCULATIONS ARE TO BE CARRIED OUT AT THE DETAILED DESIGN STAGE AND TAKE INTO ACCOUNT SPECIFIC, EXISTING SITE GROUND CONDITIONS.
- 4. DIMENSIONS OF THE OVERALL BUILDING SHALL BE DESIGNED TO SUIT MANUFACTURER SPECIFIC DIMENSIONS. ENVELOPE AROUND EQUIPMENT SHALL BE WITH MANUFACTURER RECOMMENDATIONS FOR ON-GOING OPERATION, MAINTENANCE AND REPLACEMENT.
- 5. SPECIFIC ROOM REQUIREMENTS ARE TO SUIT THE MANUFACTURER'S SPECIFICATIONS AND TO BE EVALUATED AT THE DETAILED DESIGN STAGE.
- 6. REFER TO THE LATEST REVISIONS OF THE FOLLOWING DRAWINGS FOR FURTHER DETAIL: a. PE605-D027-038-013 FOR COMPOUND 2 GENERATOR CONTROL BUILDING SECTIONS AND ELEVATIONS.
- THE FINISHED EXTERNAL BUILDING SURFACE COLOURS ARE TO BE COLOUR RAL 6006 OR SIMILAR.
- 8. WALL AND ROOF PANELS TO BE INSULATED AND METAL FACED, CORNER FLASHING TO BE PLASTISOL COATED PRESSED METAL, PARAPET AND DRIP FLASHINGS TO BE PRESSED METAL, DOORS, DOOR FRAMES, VENTS AND VENT FRAMES TO BE GALVANISED STEEL.

ACRONYMS:

R.W.P. = RAINWATER PIPEB.I.G.T. = BACK INLET GULLY TRAP

LEGEND:

	RAINWATER PIPE AND BACK INLET GULLY TRAP
0	RAINWATER PIPE AND HOPPER

RIDGE FLASHING - ROOF CLADDING ON STEEL CLADDING RAILS FIXED

- PRESSED METAL

BACK TO STEEL FRAME INSULATED GUTTER

- PRESSED METAL PARAPET FLASHING

TOP OF PARAPET

B

013

30.300 m

4		PROJECT TITLE REVISE	D		SB						
3	21.08.23	BUILDING SIZE REVISEI	D, GRID LINES REMO	VED	SB	SB	SD	JMcL			
2	23/06/22	BUILDING REVISED TO TWO STOREY				SB	SD	SS			
1	09/05/22	GENERATOR, HOUSE TRANSFORMER AND TEXT DETAILS UPDATED. DIMENSIONS ADDED.				RH	SD	SS			
0	17/12/20	INITIAL VERSION				RH	BP	SK			
REV DATE REVISION DESCRIPTION						PROD	VER	APP			
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	PURPOSE OF ISSUE - PRELIMINARY UNLESS INDICATED										
CLIENT Oriel Windfarm Limited											
Oriel Wind Farm Project											
CONTRACT											
DRAWING TITLE ONSHORE SUBSTATION COMPOUND 2 CONTROL BUILDING PLANS											
PRODUCTION UNIT Civil, Environmental and Renewable Engineering											
Energy for generations Engineering and Major Projects, One Dublin Airport Central, Dublin Airport, Cloghran, Co. Dublin, K67 XF72, Ireland. Tel: +353 (0)1 703 8000 Web: www.esb.ie Engineering and Major Projects is a division of ESB.											
DRA	WN	PRODUCED	VERIFIED	APPROVED		APPR	OVAL E	DATE			
	S.Bolton	S.Bolton	S. Donnelly	J.McLough	hlin		/02/20:	24			
CLIE	NT REF	TC223815	NO. OF SHTS 1	SIZE A1		SCAL	E 1:100				
DRAWING NUMBER SHEET REV PE605-D027-038-012-004											